


EXHIBIT B




E.G.
ENGINEERING
250 4TH AVE. S., SUITE 200
EDMONDS, WASHINGTON 98020
PHONE (425) 778-8500
FAX (425) 778-5536





NORRIS RESIDENCE
25408 RIATA ROAD
LEAVENWORTH, WA

SITE PLAN



SO.1

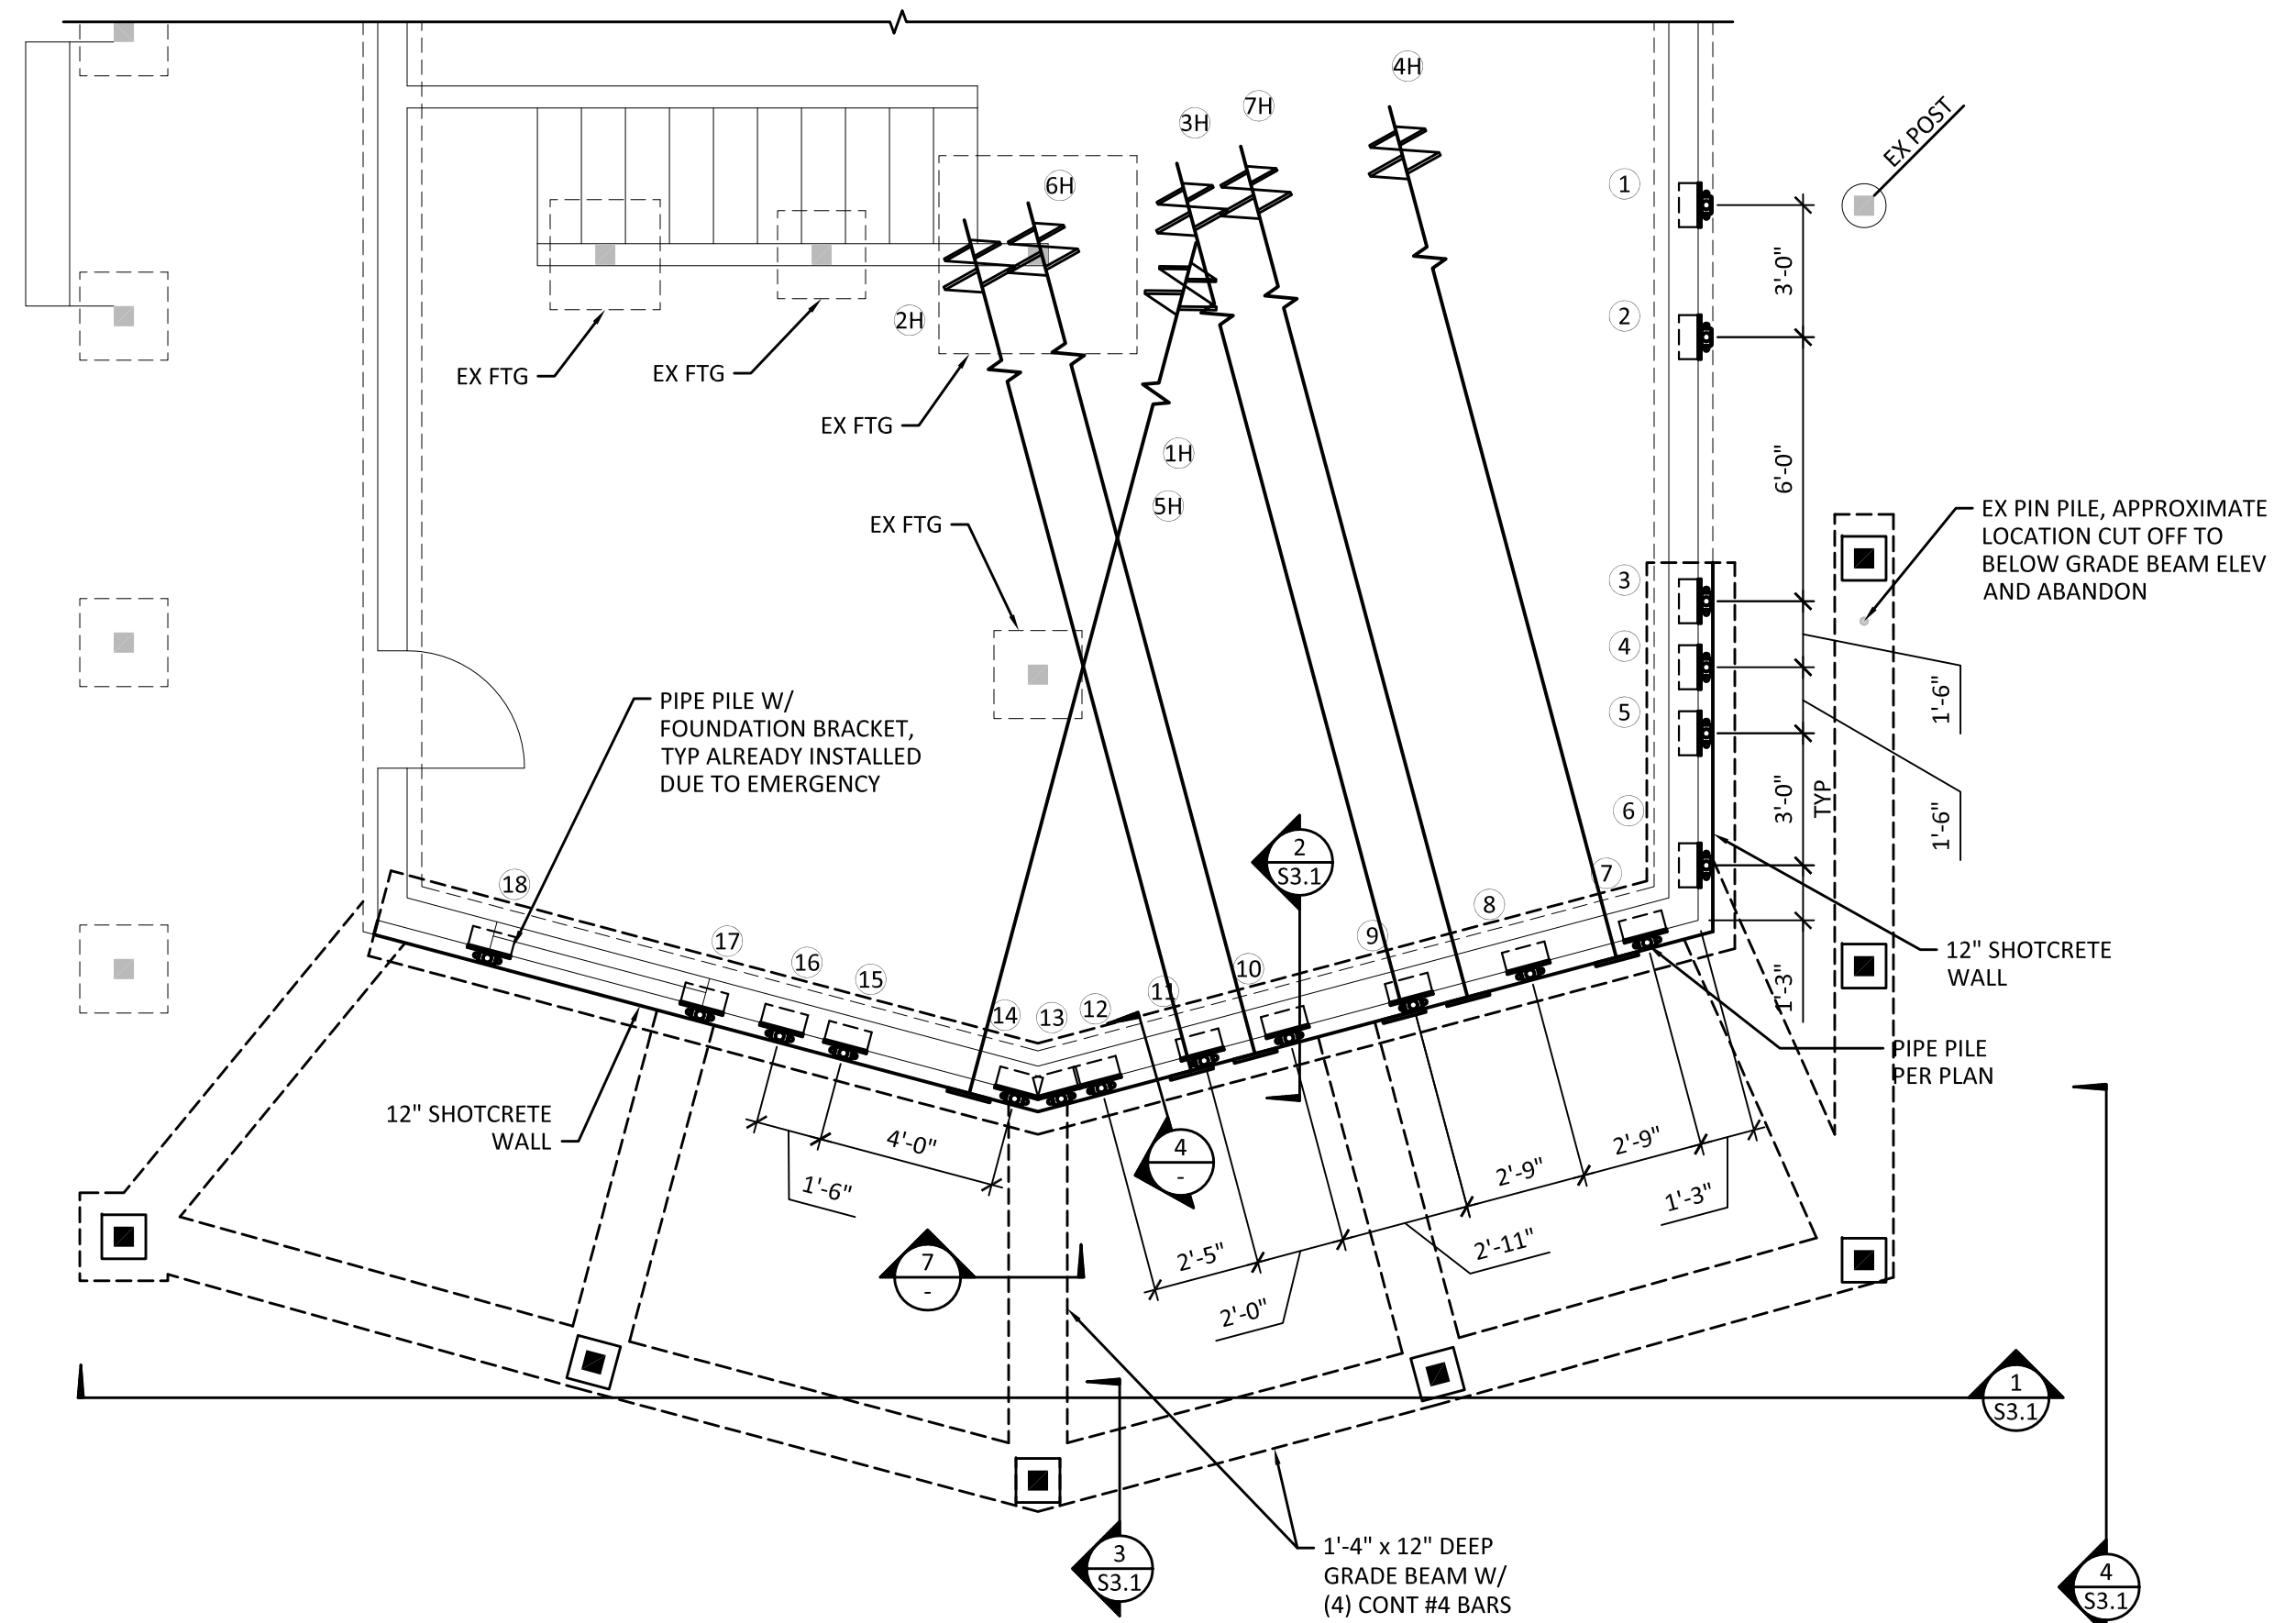


1 PARTIAL FOUNDATION PLAN
SCALE: 1/4" = 1'-0"

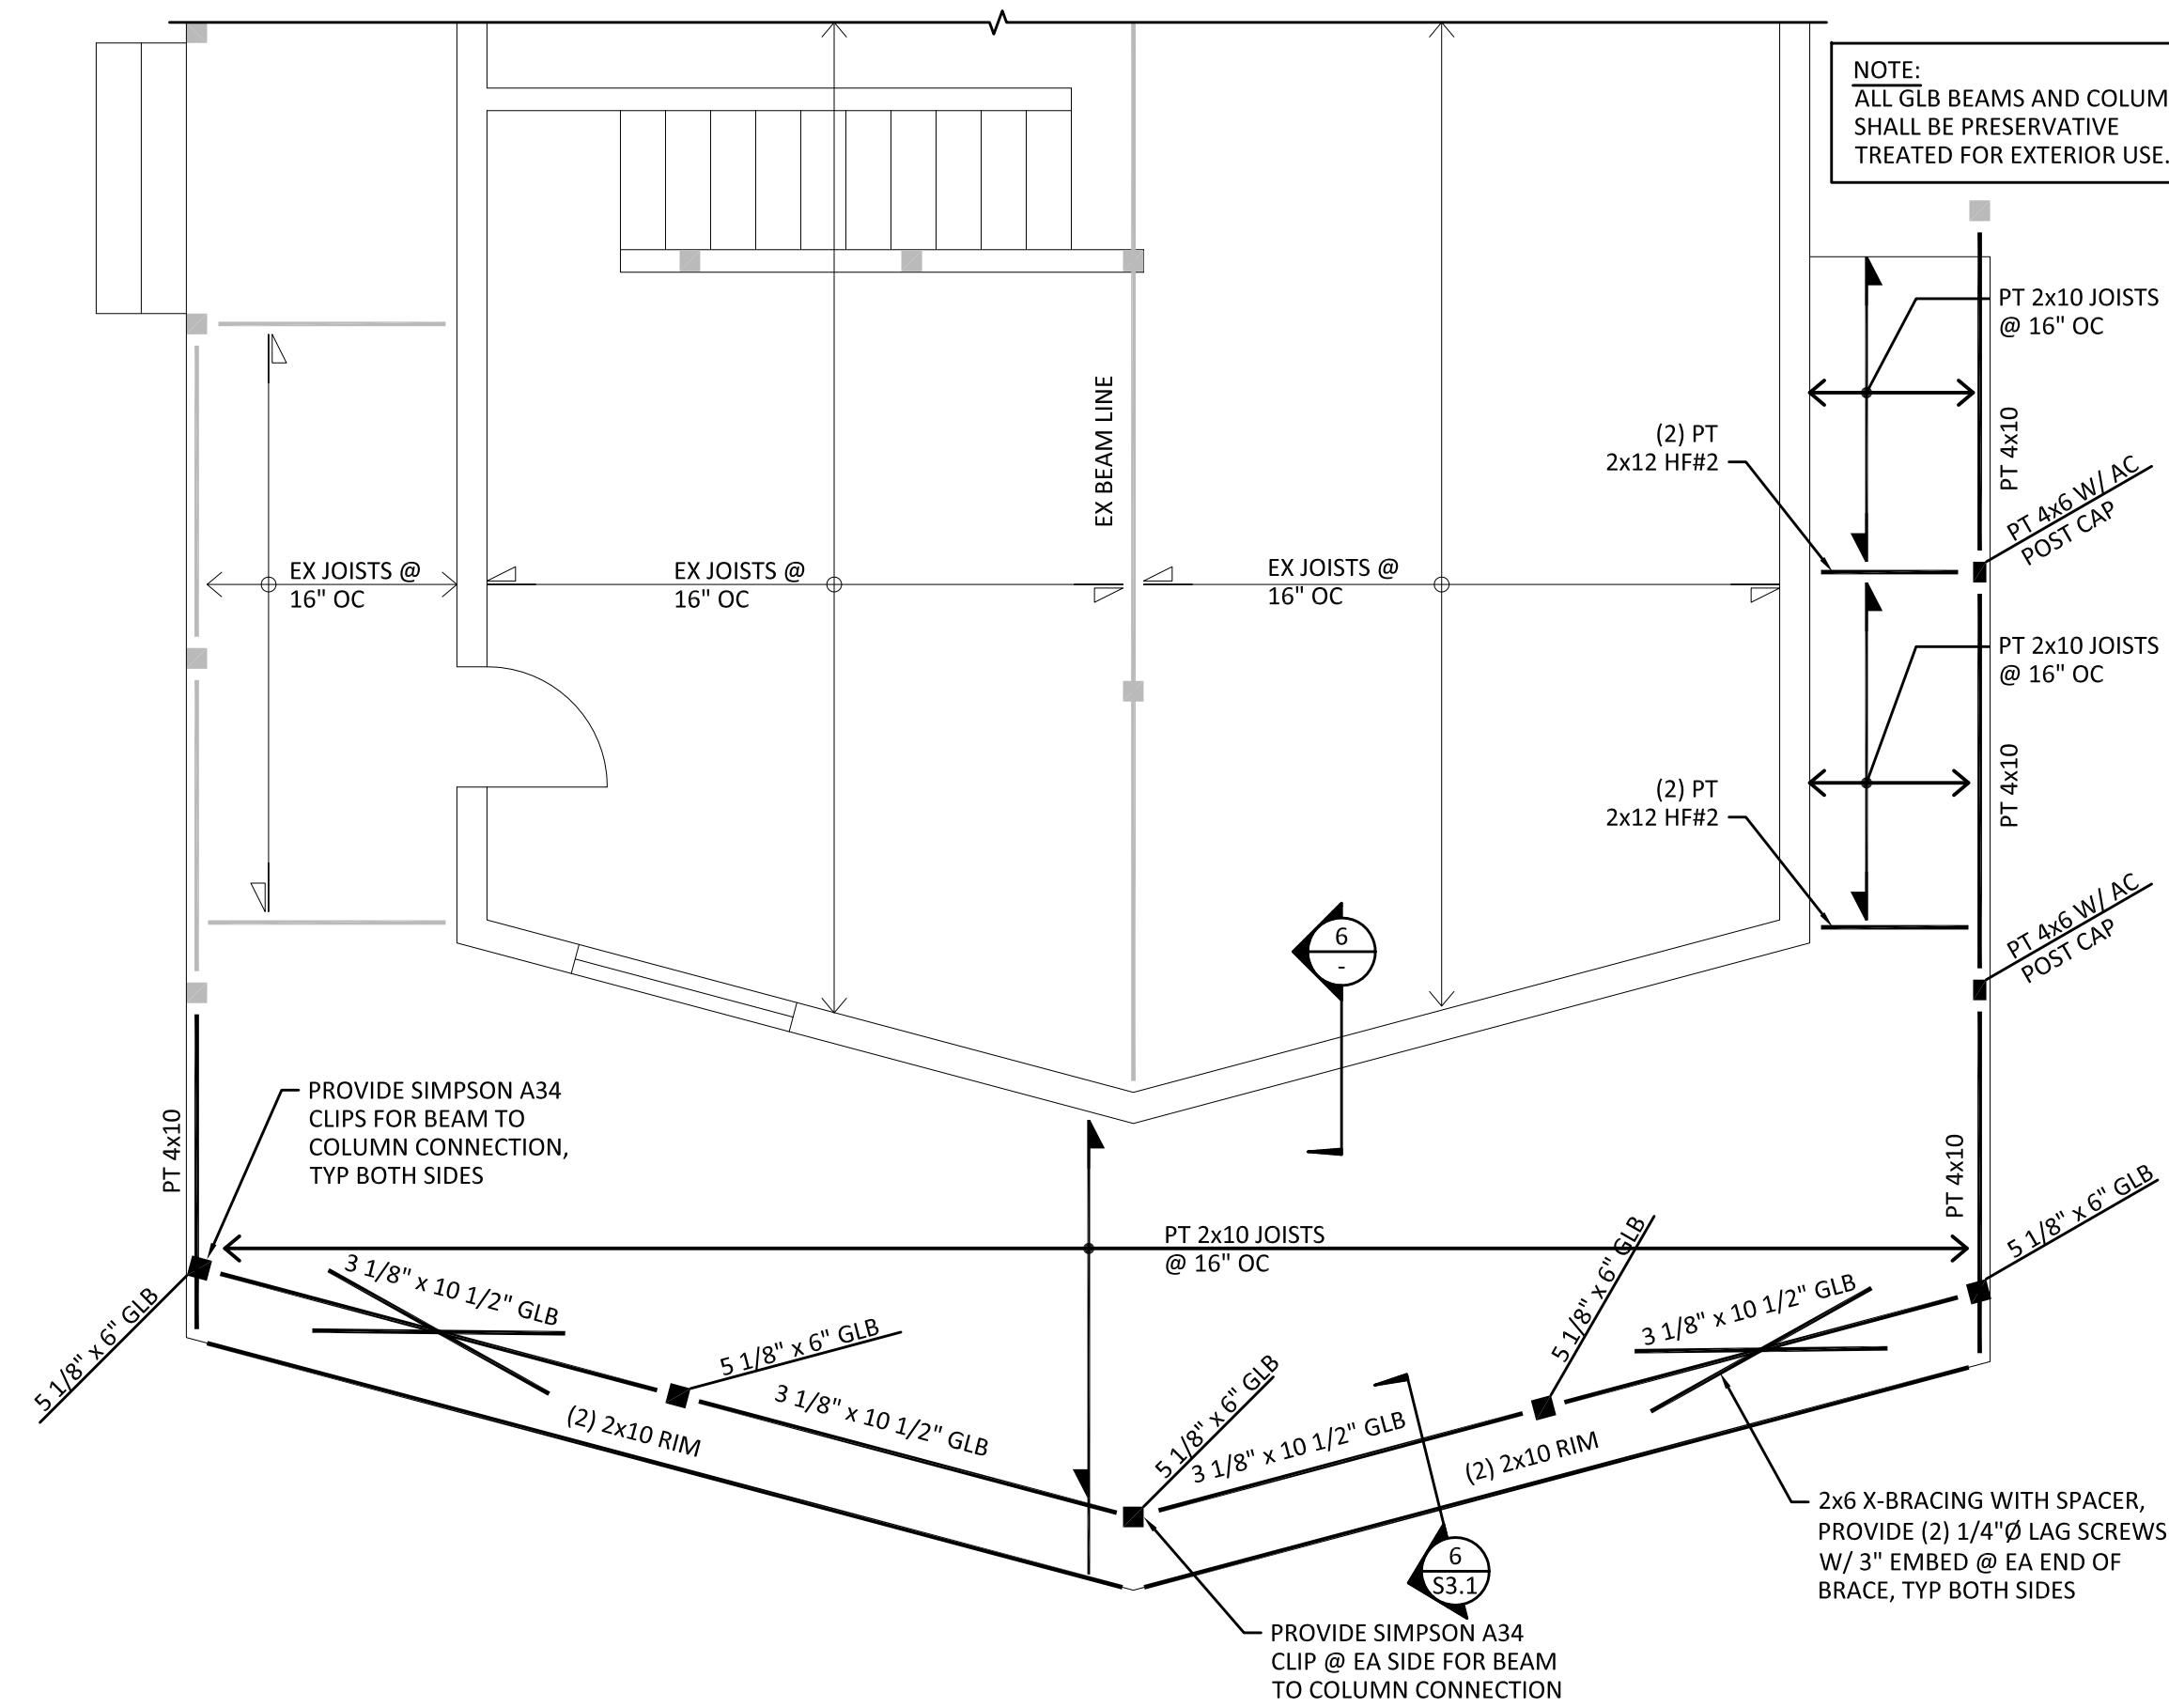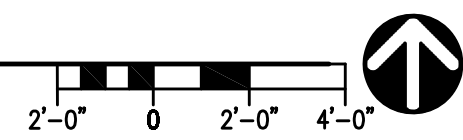

2 PARTIAL MAIN FLOOR FRAMING PLAN
SCALE: 1/4" = 1'-0"

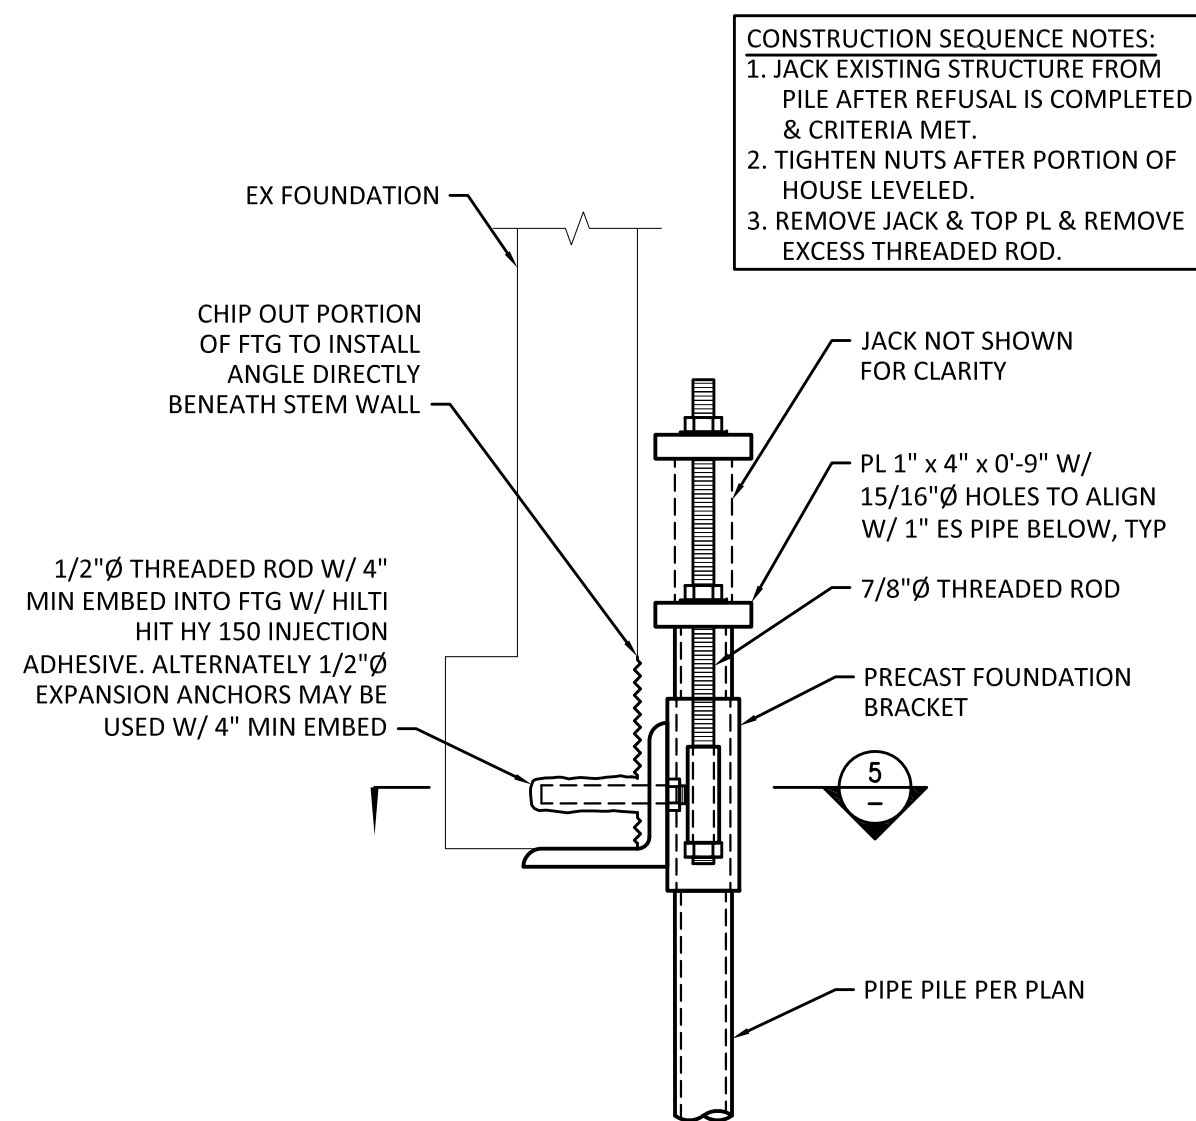
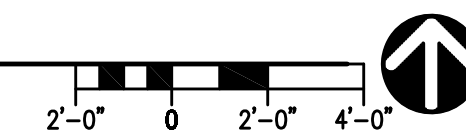


4 TYPICAL DETAIL
SCALE: 1 1/2" = 1'-0"

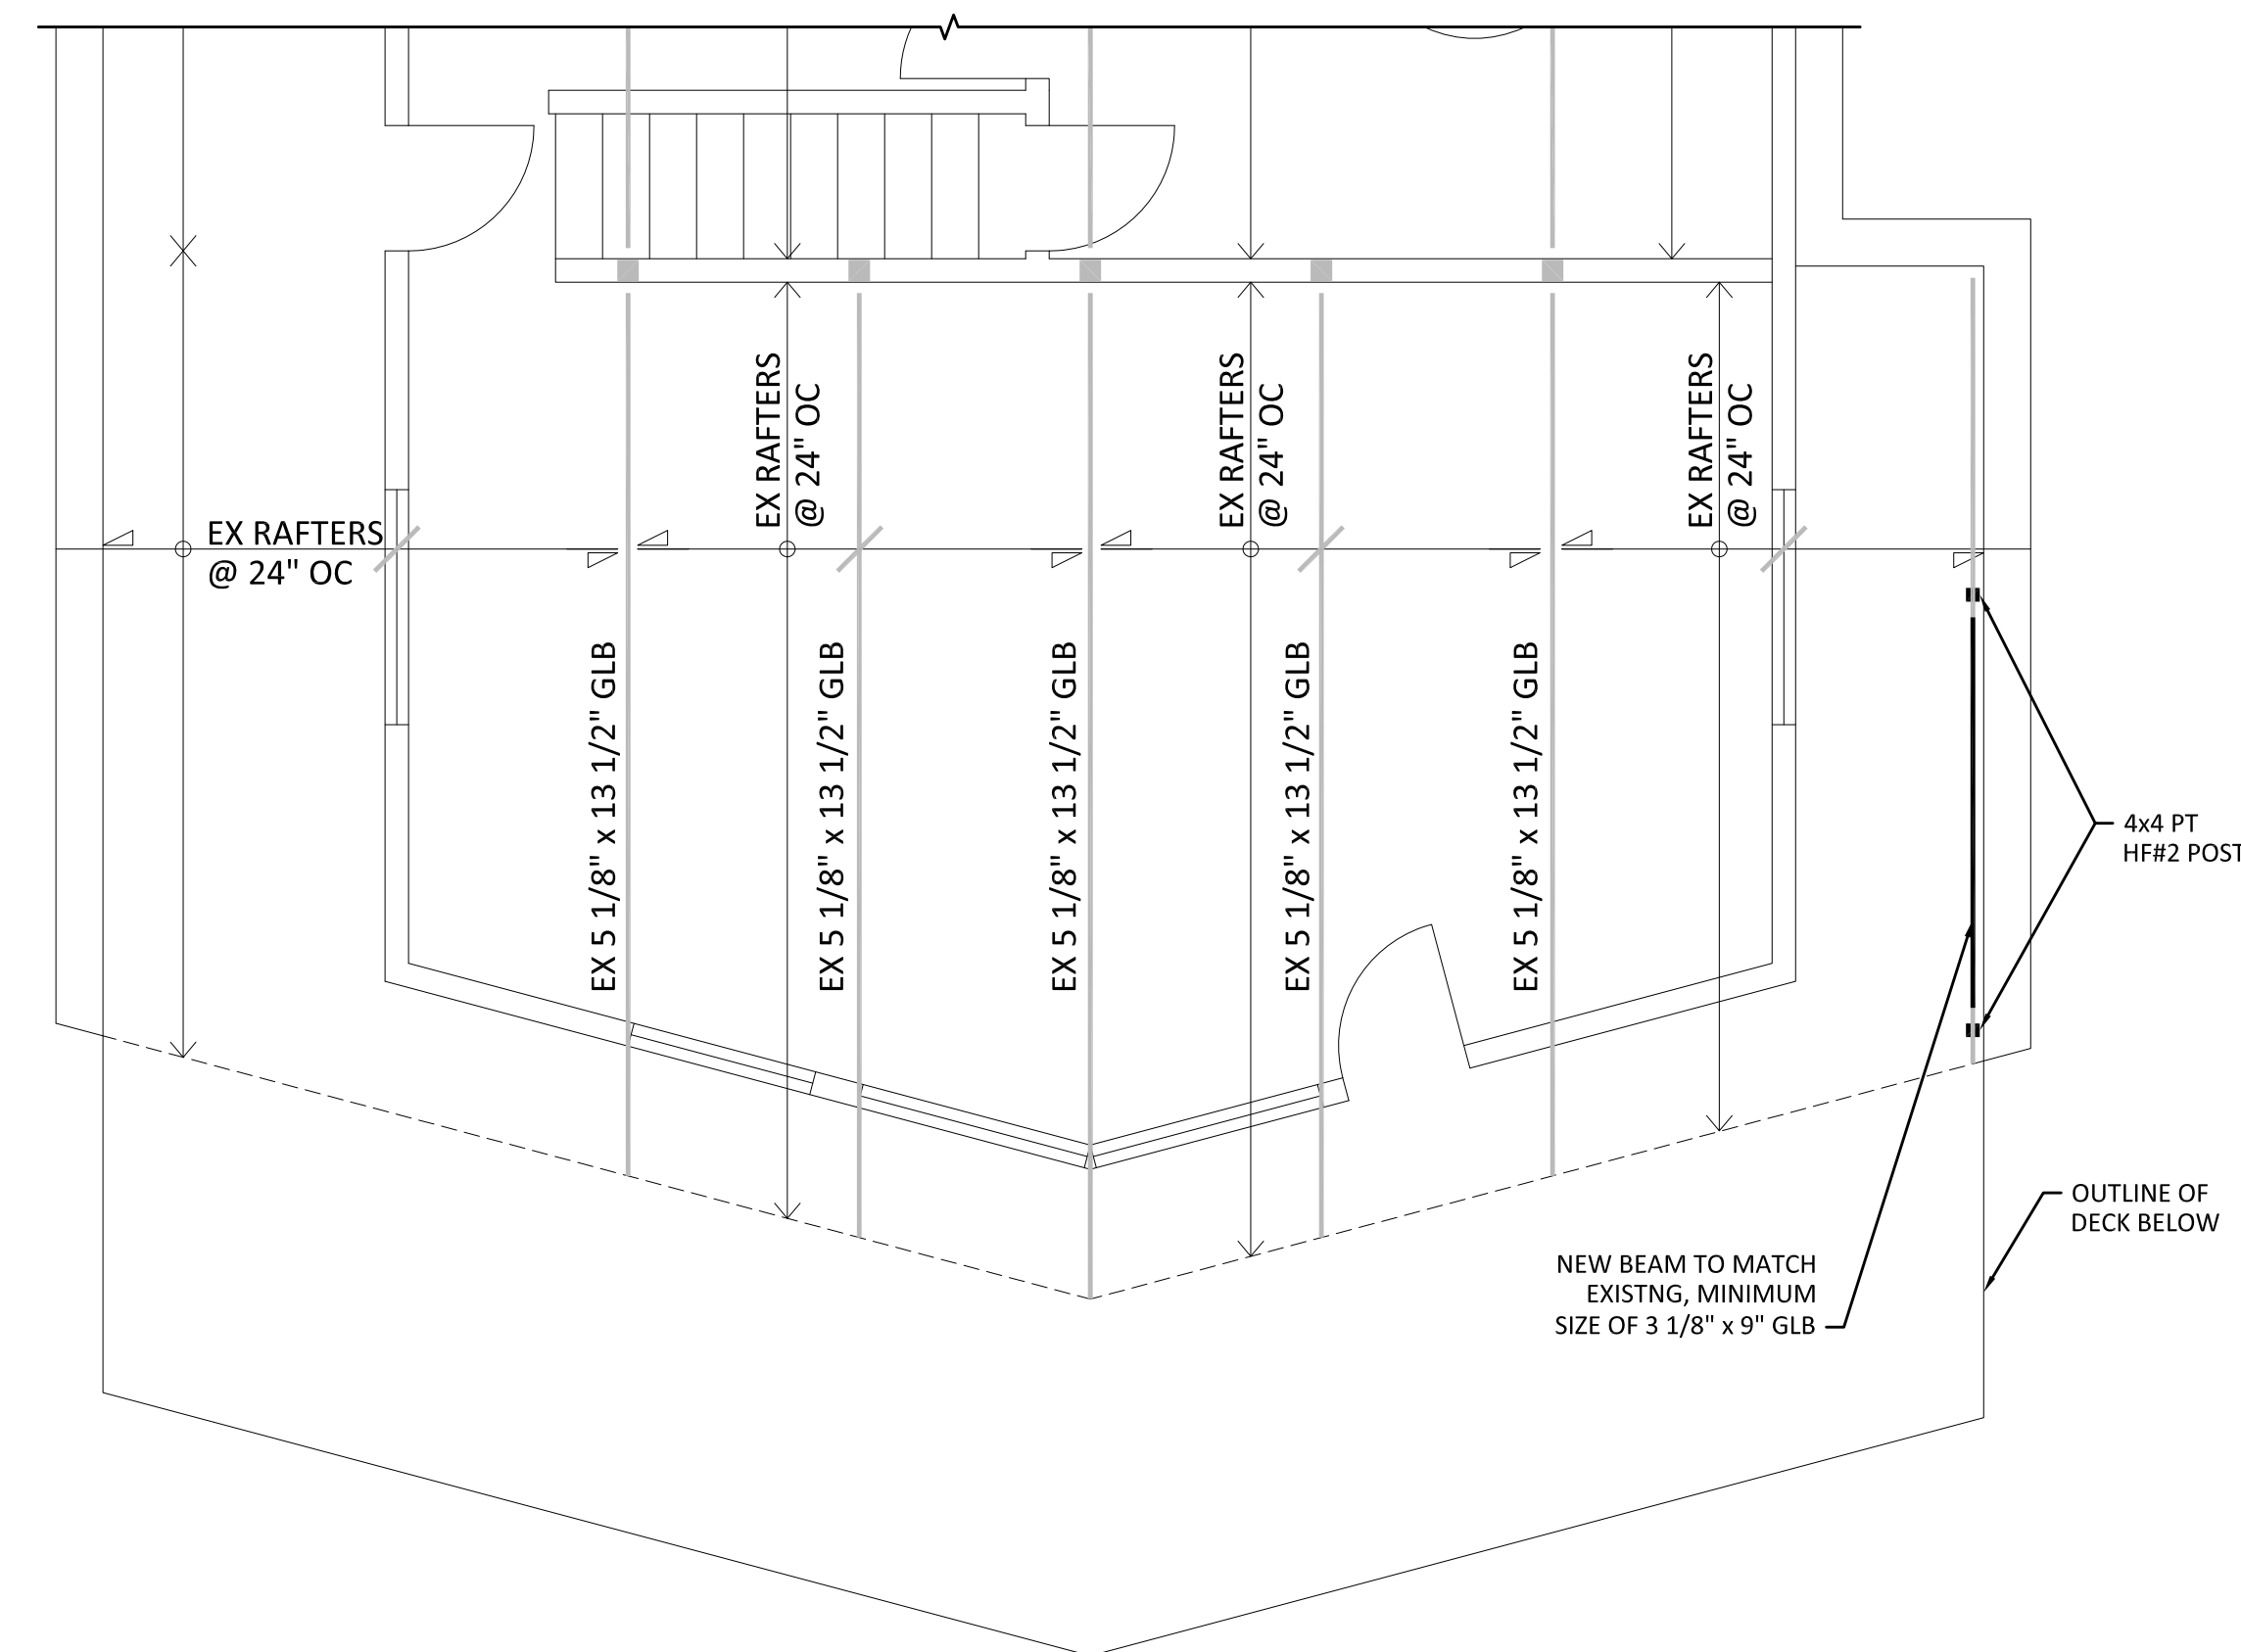


3 PARTIAL ROOF FRAMING PLAN

SCALE: 1/4" = 1'-0"

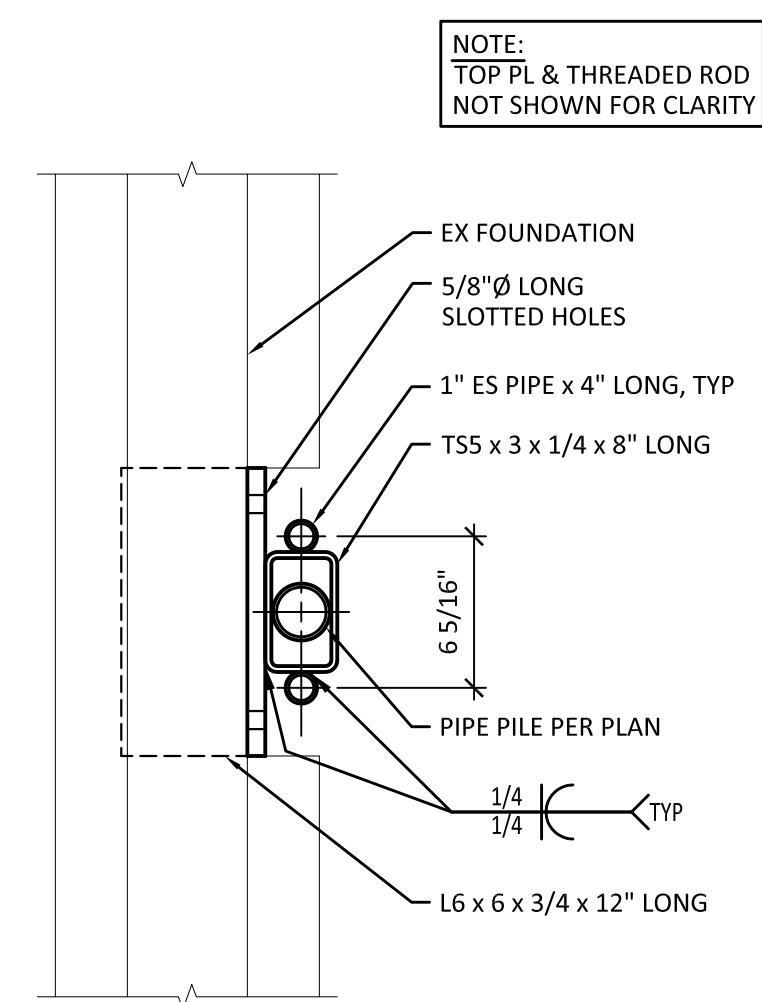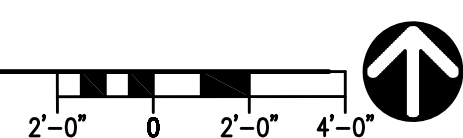


5 TYPICAL DETAIL
SCALE: 1 1/2" = 1'-0"

6 SECTION
SCALE: 1" = 1'-0"

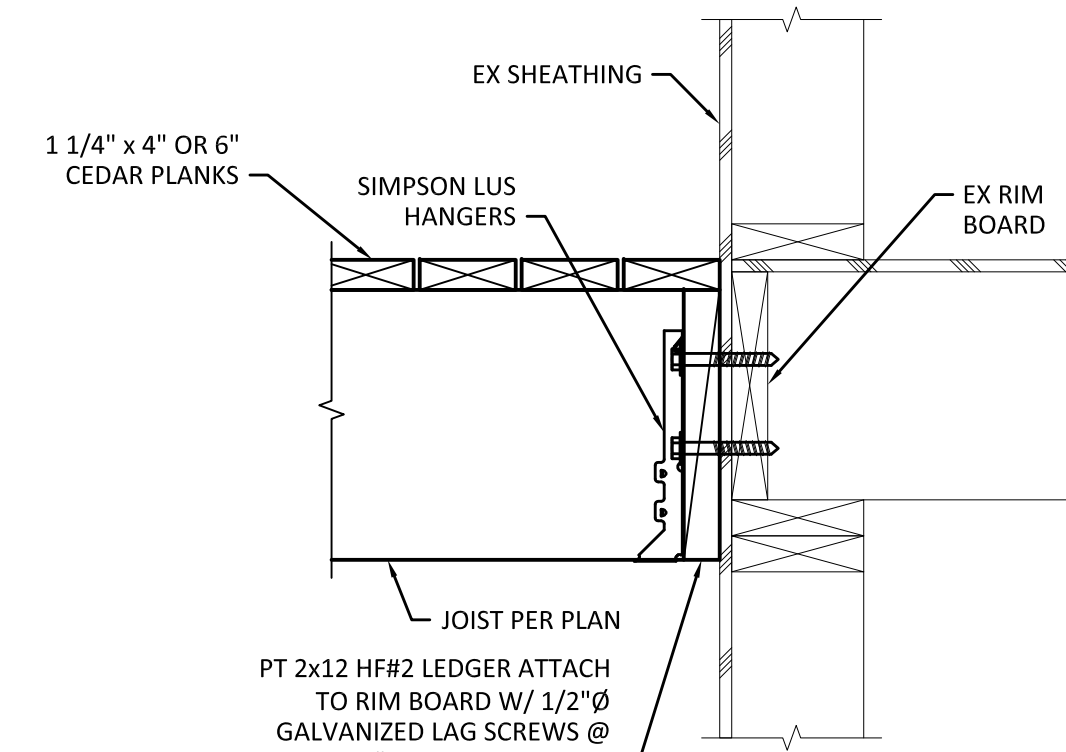

6 SECTION
SCALE: 1" = 1'-0"

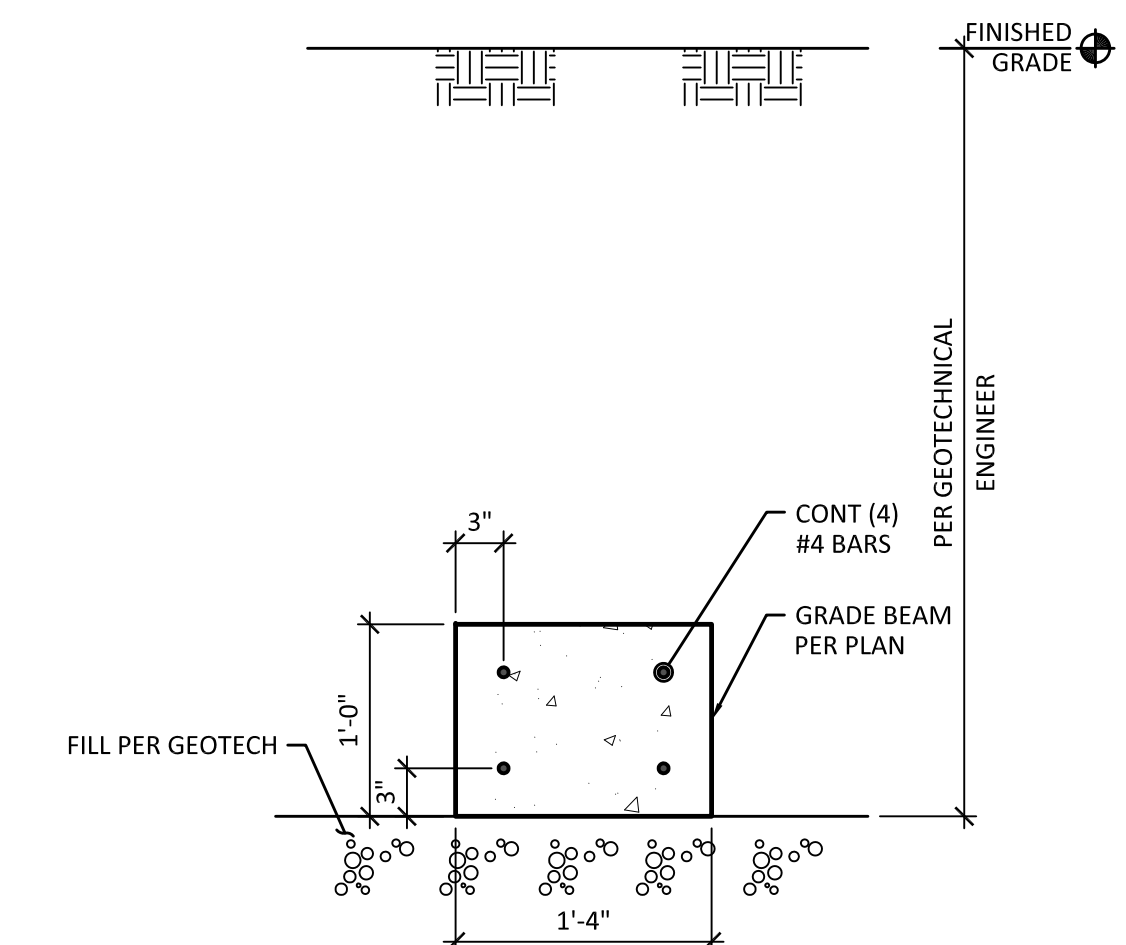

7 SECTION
SCALE: 1" = 1'-0"

[illegible]

DESIGN:	DTR
DRAWN:	JCS
CHECK:	DMT
JOB NO:	13209.10.2
DATE:	06/10/14

NORRIS RESIDENCE
25408 RIATA ROAD
LEAVENWORTH, WA

EMERGENCY FOUNDATION
STABILIZATION PLAN & DETAILS


LE NAME:

SHEET:


S2.1

ANCHOR	ANCHOR PLATE	DESIGN LOAD	LOCK OFF LOAD
1H	PL 1 x 8 x 0'-8"	17.9K	12.5K
2H	PL 1 x 8 x 0'-8"	22.4K	15.6K
3H	PL 1 x 8 x 0'-8"	22.4K	15.6K
4H	PL 1 x 8 x 0'-8"	17.9K	12.5K
5H	PL 1 x 8 x 0'-8"	13.6K	8.5K
6H	PL 1 x 8 x 0'-8"	9.0K	5.7K
7H	PL 1 x 8 x 0'-8"	13.6K	8.5K


NOTES:
1. ALL FOOTINGS SHALL BEAR ON FIRM, UNDISTURBED NATIVE SOIL OR COMPACTED STRUCTURAL FILL PER GEOTECHNICAL ENGINEERING REPORT.
2. REINFORCEMENT SHALL BE CONTINUED FROM CONTINUOUS FOOTINGS THRU SPREAD FOOTINGS WHERE APPLICABLE.
3. CONTRACTOR SHALL NOTIFY ENGINEER IF ANCHOR LOADS CANNOT BE ACHIEVED.
4. ALL ANCHORS SHALL BE INSTALLED TO 200% OF THE DESIGN.

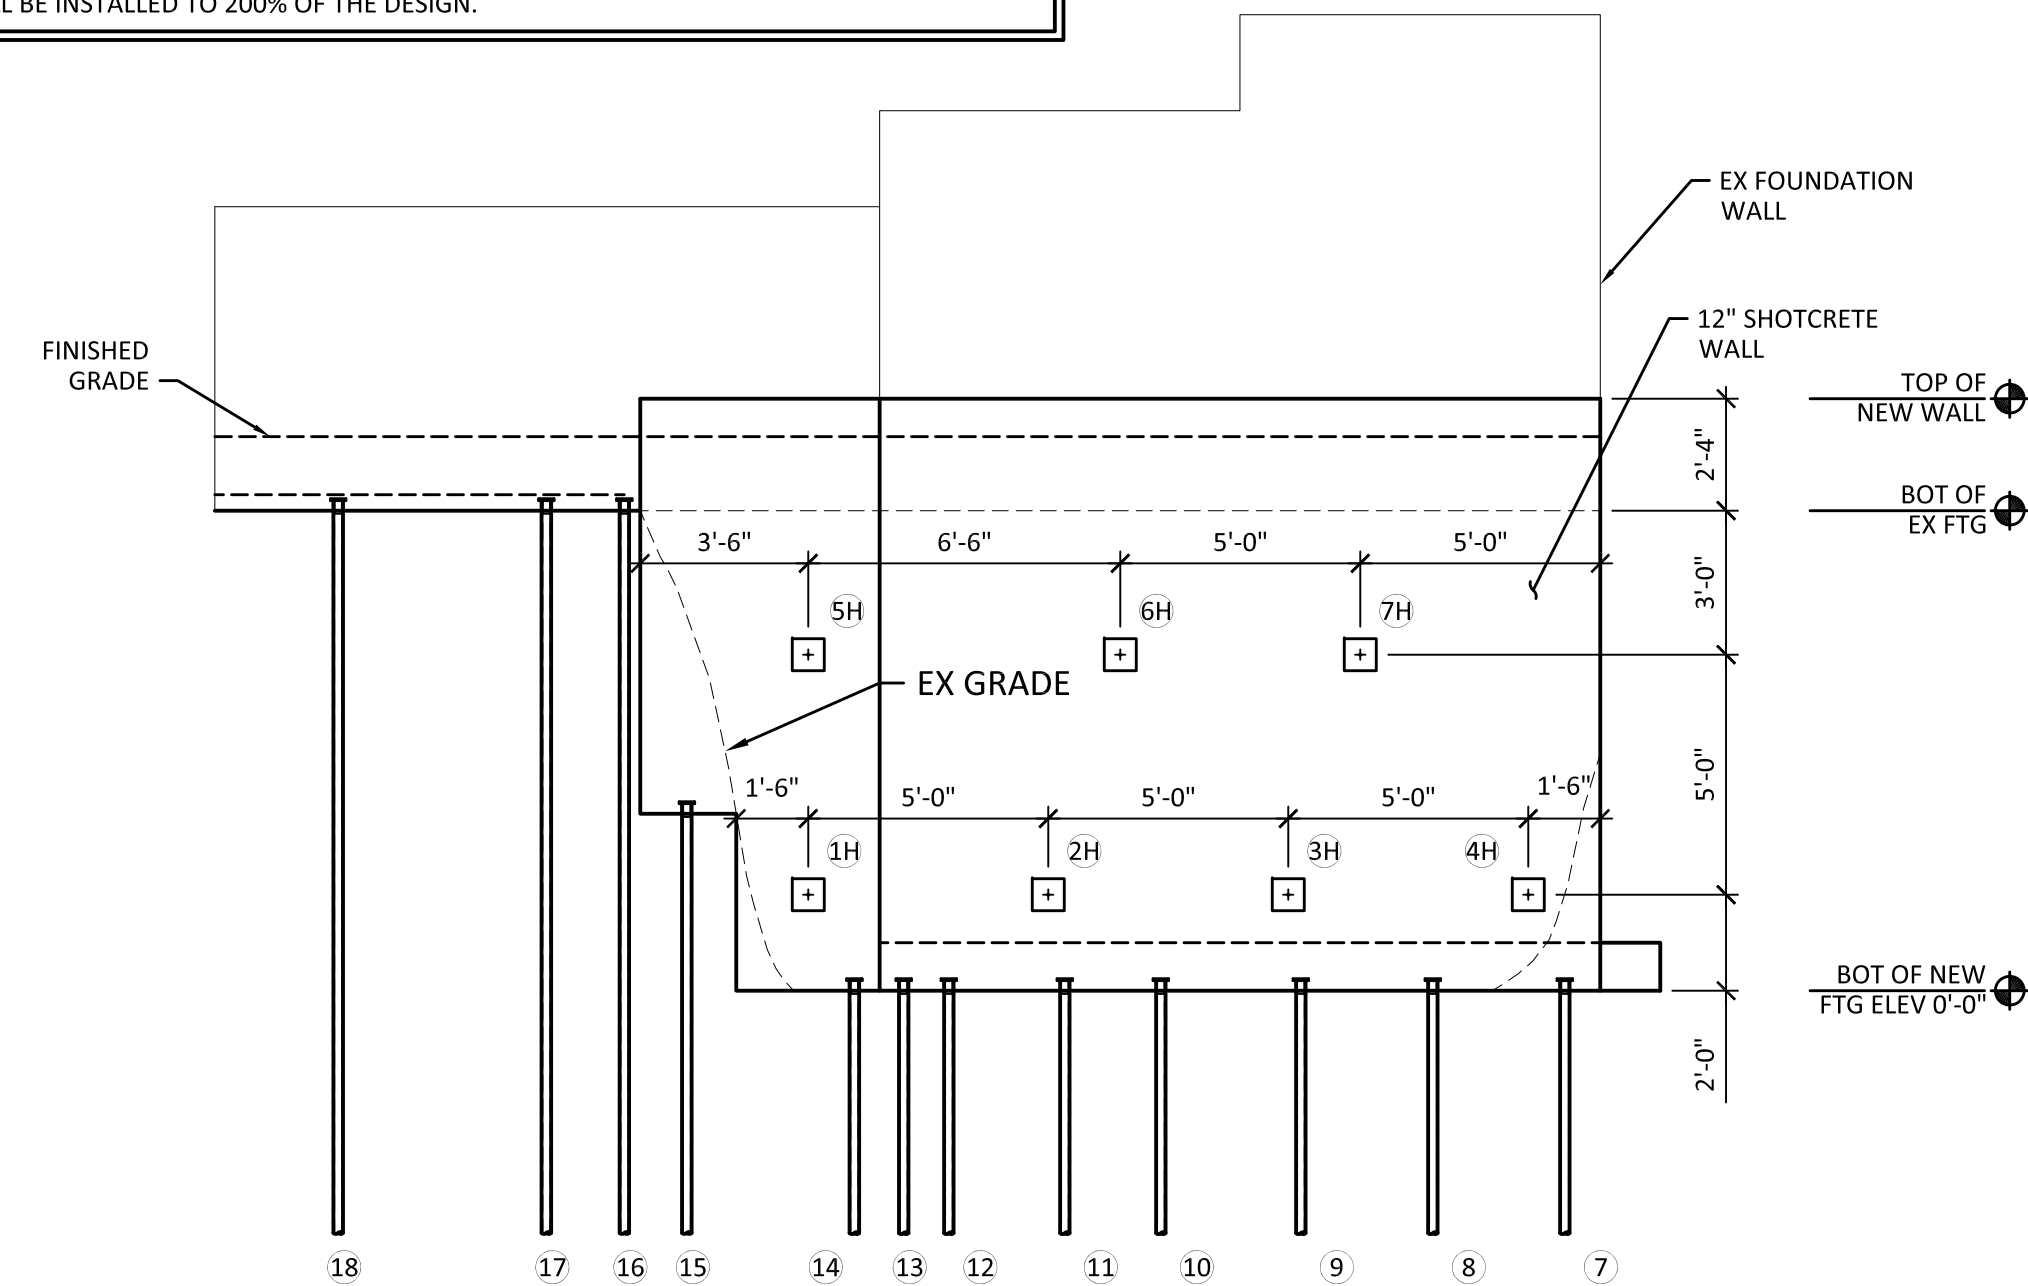


1 PROFILE
SCALE: 1/4" = 1'-0"

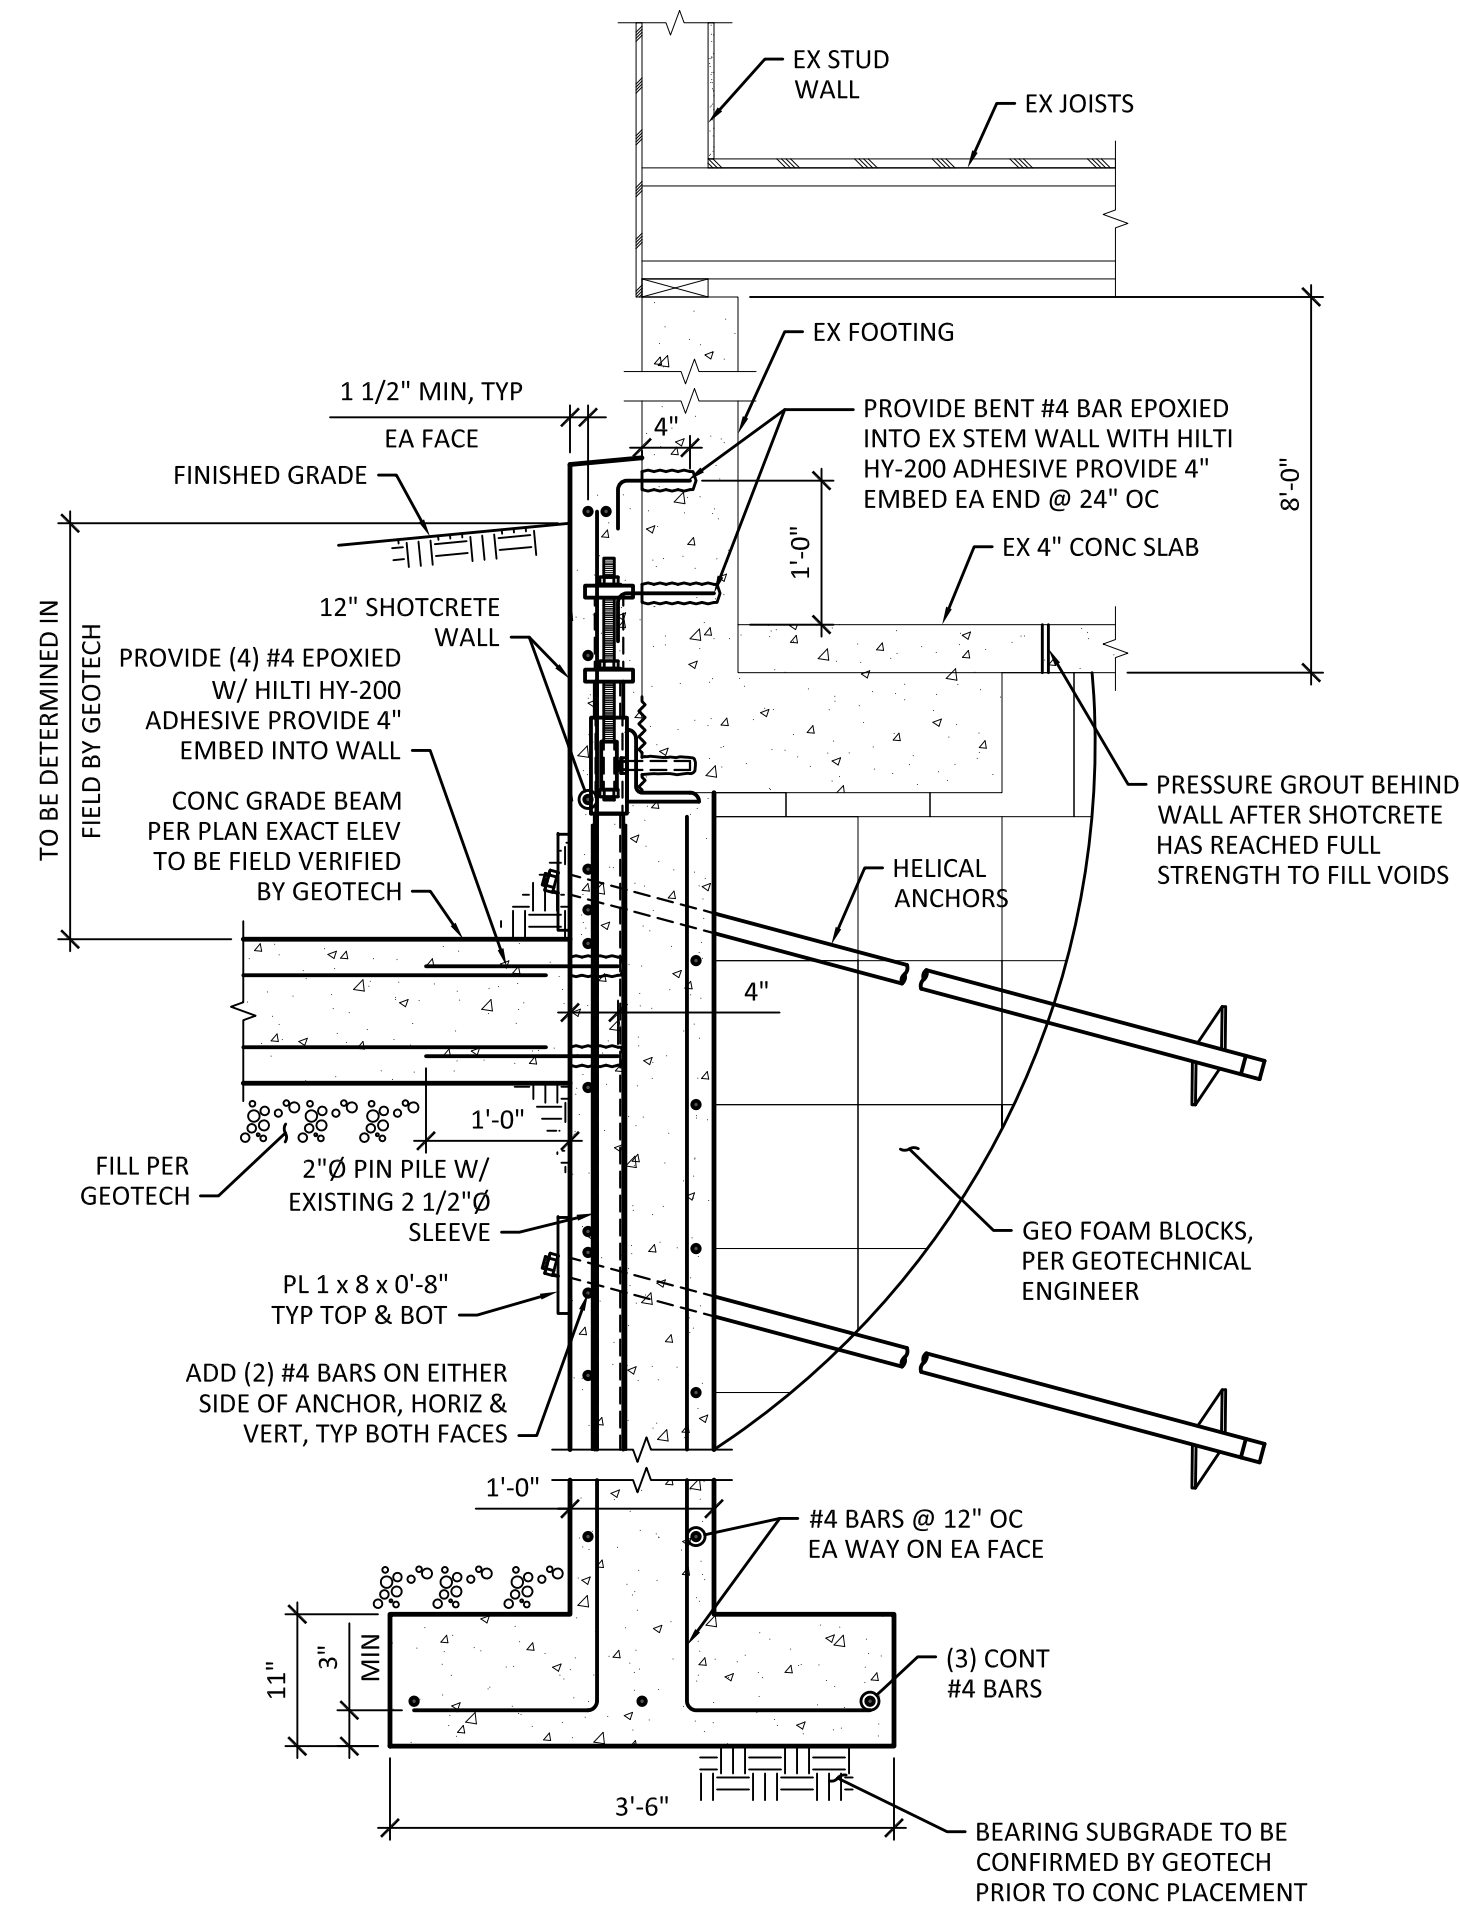


2 SECTION
SCALE: 3/4" = 1'-0"

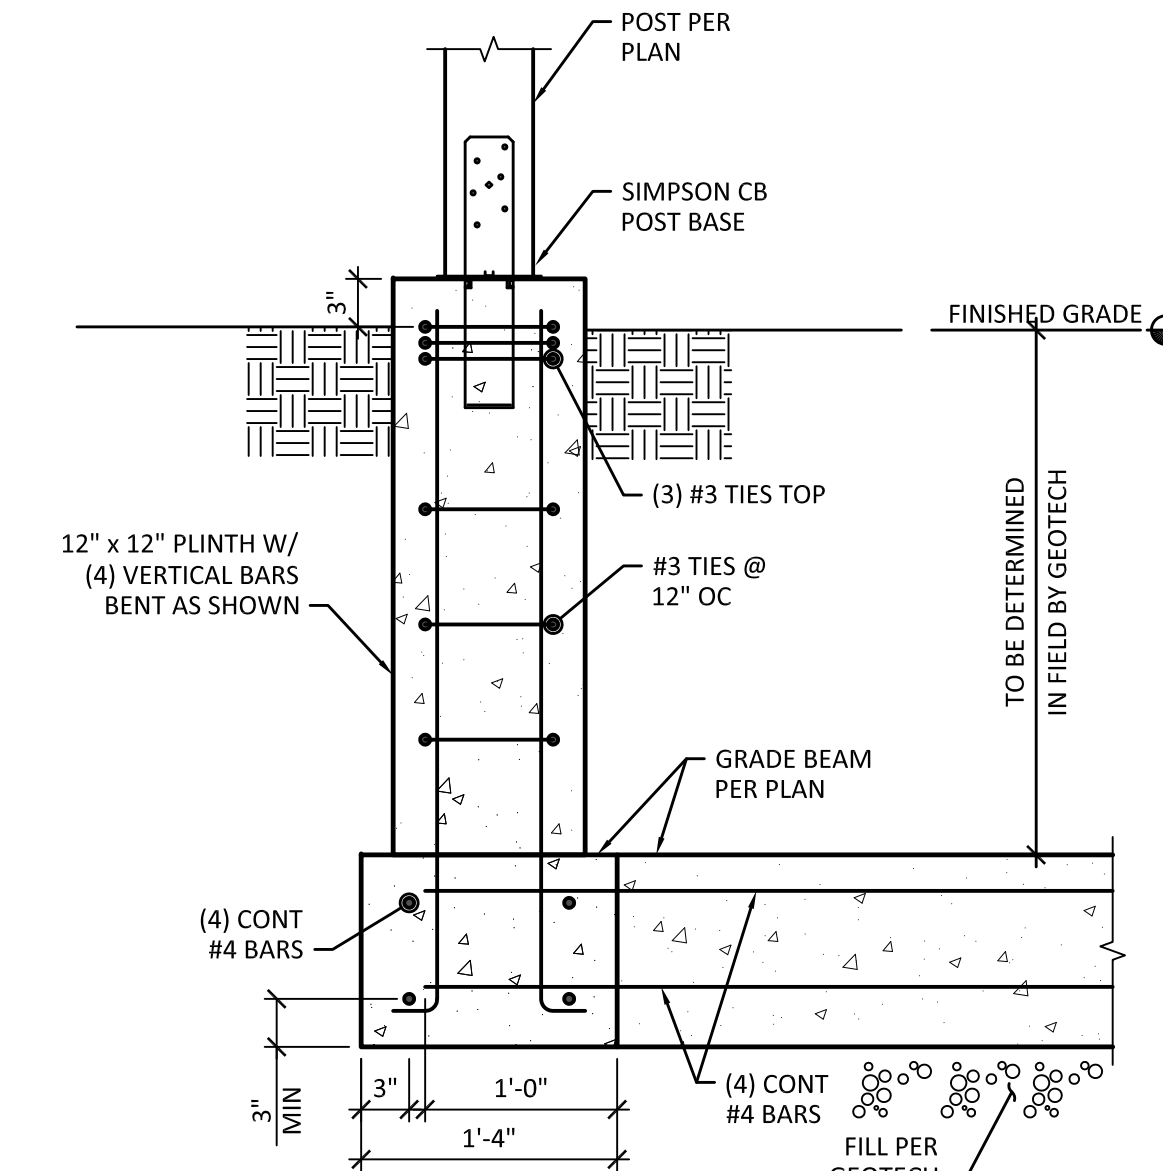


3 SECTION
SCALE: 1" = 1'-0"

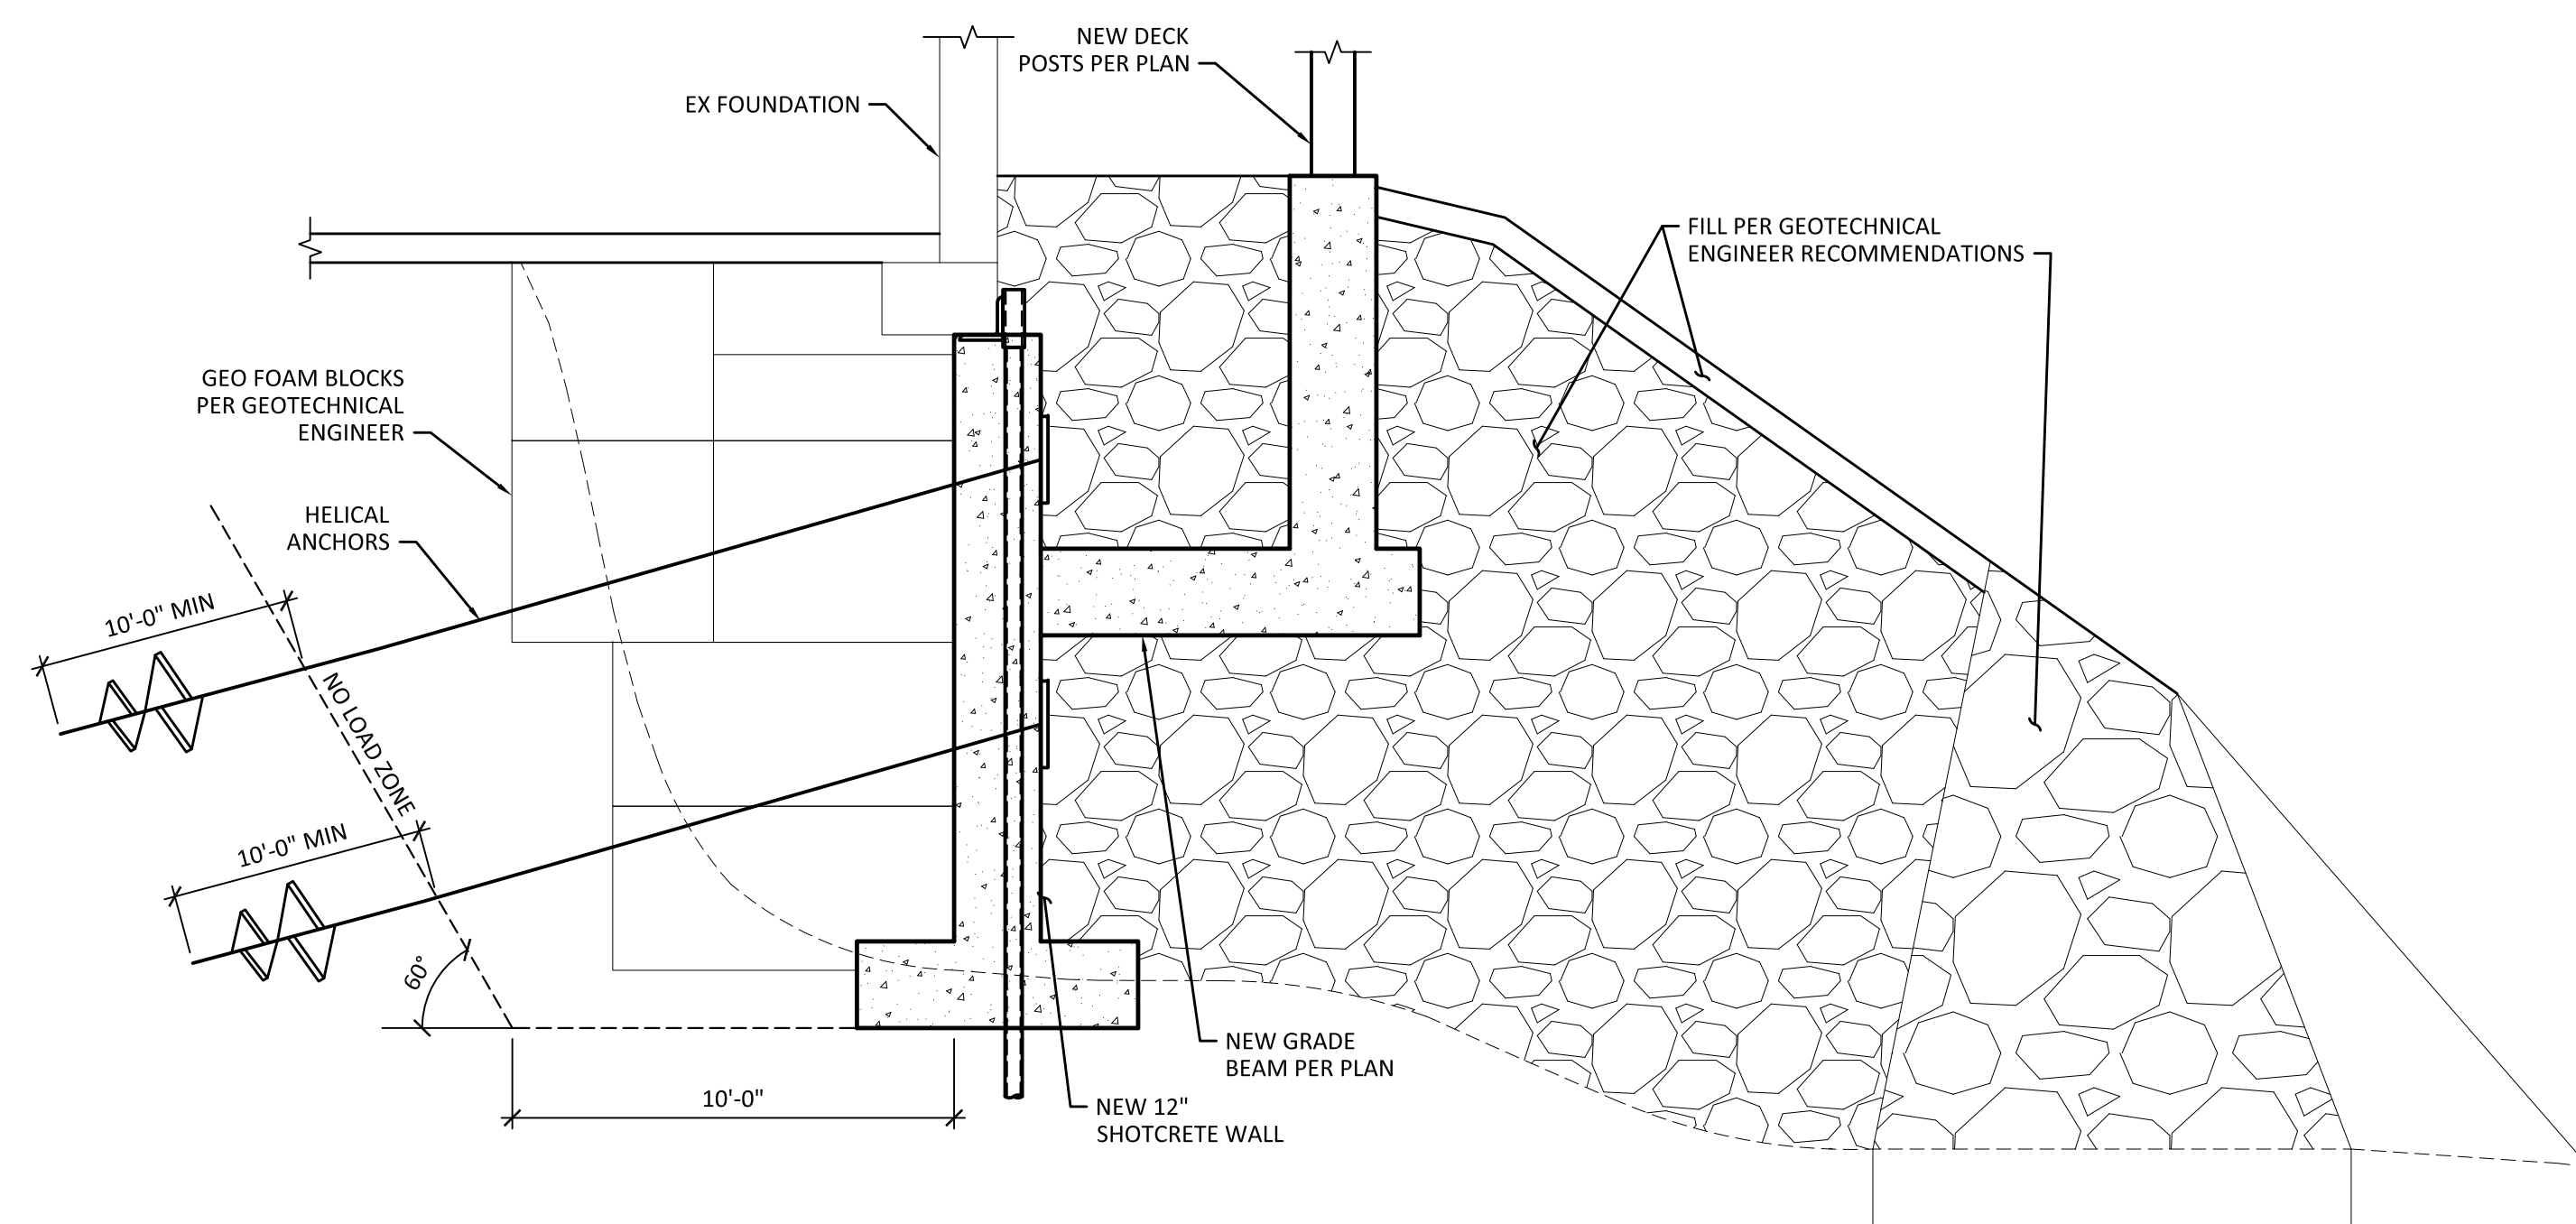

4 SECTION
SCALE: NTS

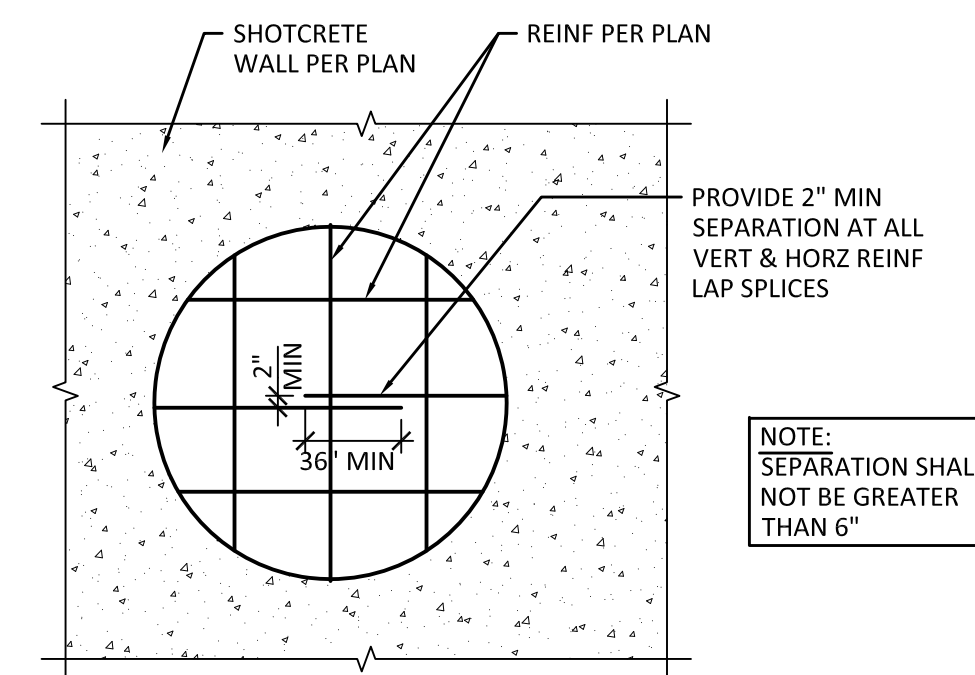

5 TYPICAL NONCONTACT LAP SPLICE
SCALE: NTS

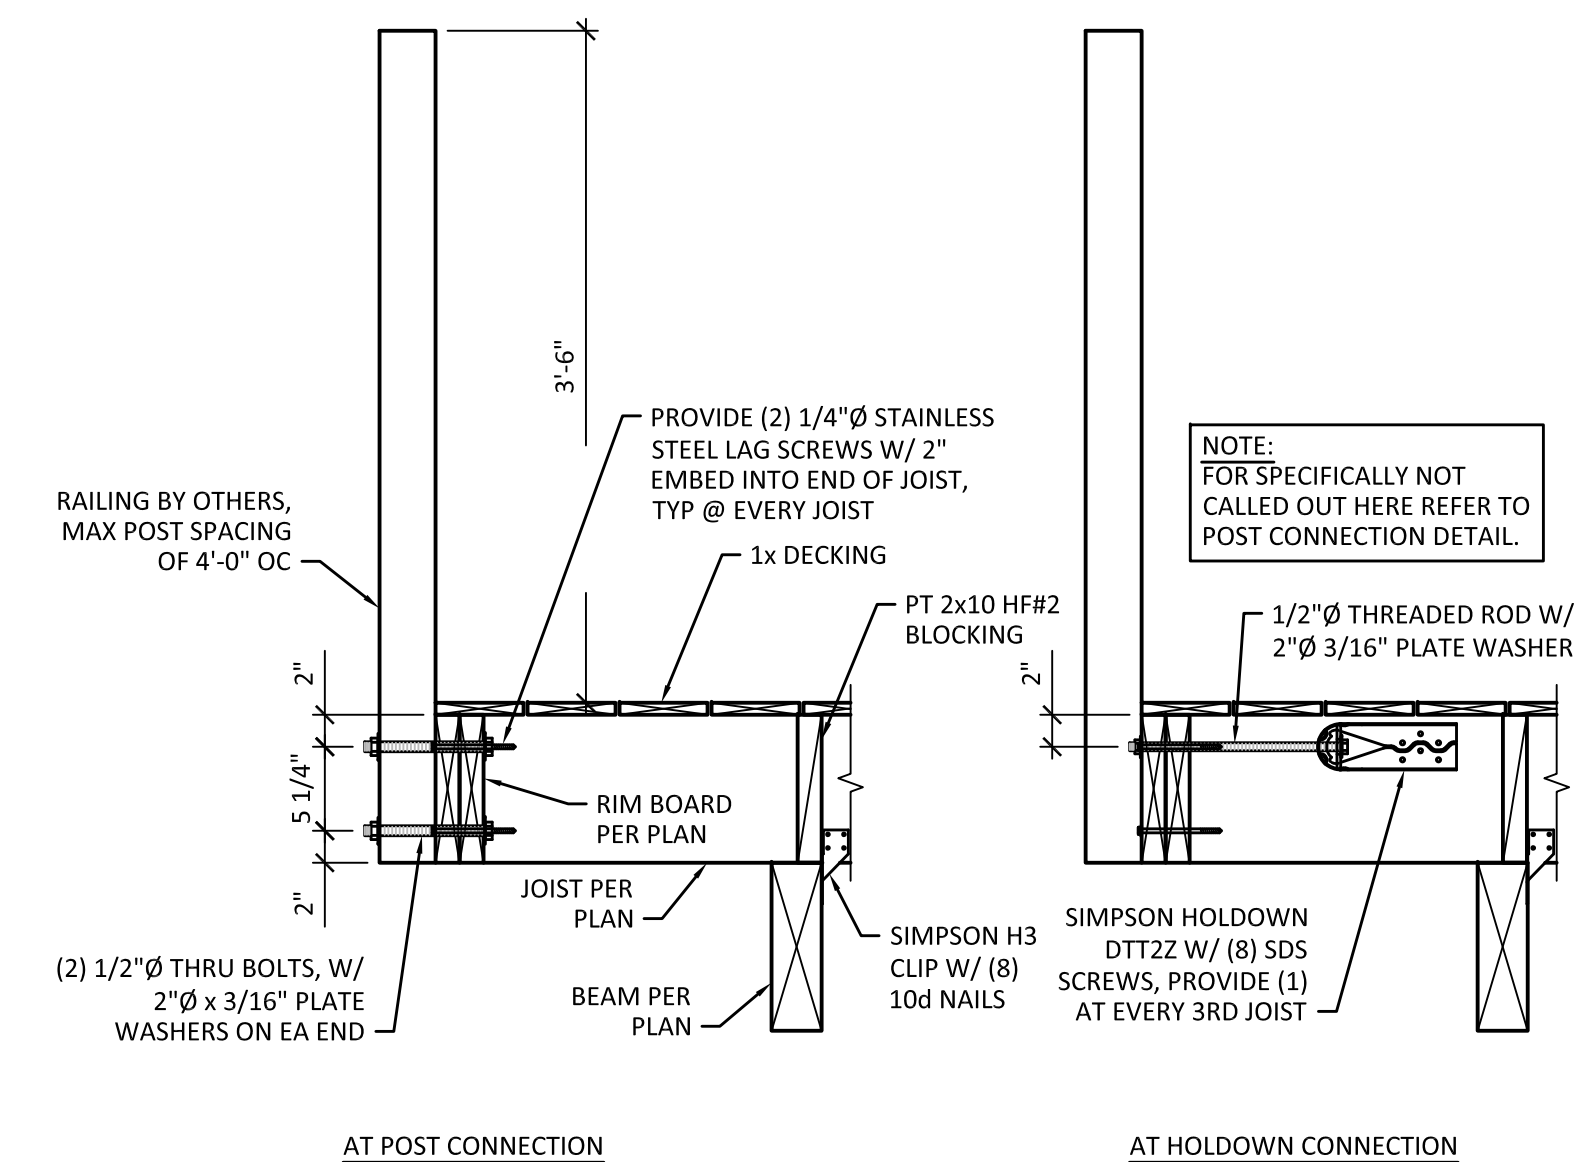

6 SECTION
SCALE: 1" = 1'-0"



06/10/14

[illegible]

DESIGN:	DTR
DRAWN:	JCS
CHECK:	DMT
JOB NO:	13209.10.2
DATE:	06/10/14

NORRIS RESIDENCE
25408 RIATA ROAD
LEAVENWORTH, WA

EMERGENCY FOUNDATION
STABILIZATION PLAN & DETAILS

SHEET:

S3.1